SITE DEVELOPMENT PLAN

FOR

I497 GRAFTON ROAD MILLBURY, MASSACHUSETTS 01527

RECORD APPLICANT:

PARKLUND PLACE, LLC

4 ABBOTT PLACE

MILLBURY, MA 01527

(508) 335-7191

RECORD OWNER:

PARKLUND PLACE, LLC 4 ABBOTT PLACE MILLBURY, MA 01527 (508) 335-7191

LAND PLANNERS-CIVIL ENGINEERS:

J.M. GRENIER ASSOCIATES INC. 325 DONALD LYNCH BOULEVARD SUITE 100 MARLBOROUGH, MA 01752 (508) 845-2500

LAND SURVEYORS: REALMAPINFO, LLC
11 APEX DRIVE SUITE 300 S
MARLBOROUGH, MA 01752

MODULETON STREET

ACCESS FURNING OF STREET

ACCES FURNING O

LOCUS: SCALE: 1'=100' DESCRIPTION 1 OF 9 COVER EXISTING CONDITIONS PLAN 2 OF 9 LAYOUT PLAN 3 OF 9 GRADING AND DRAINAGE PLAN 4 OF 9 UTILITY PLAN 5 OF 9 LANDSCAPE AND LIGHTING PLAN 6 OF 9 EROSION & SEDIMENTATION 7 OF 9 CONTROL PLAN

SITE PLAN APPROVAL
MILLBURY PLANNING BOARD

DATE:

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DETAIL PLAN

2/9/22

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REV. NO. DATE REVISION

SCALE:

AS SHOWN

COVER SHEET


SHEET NO.:
SHEET 1 OF 9


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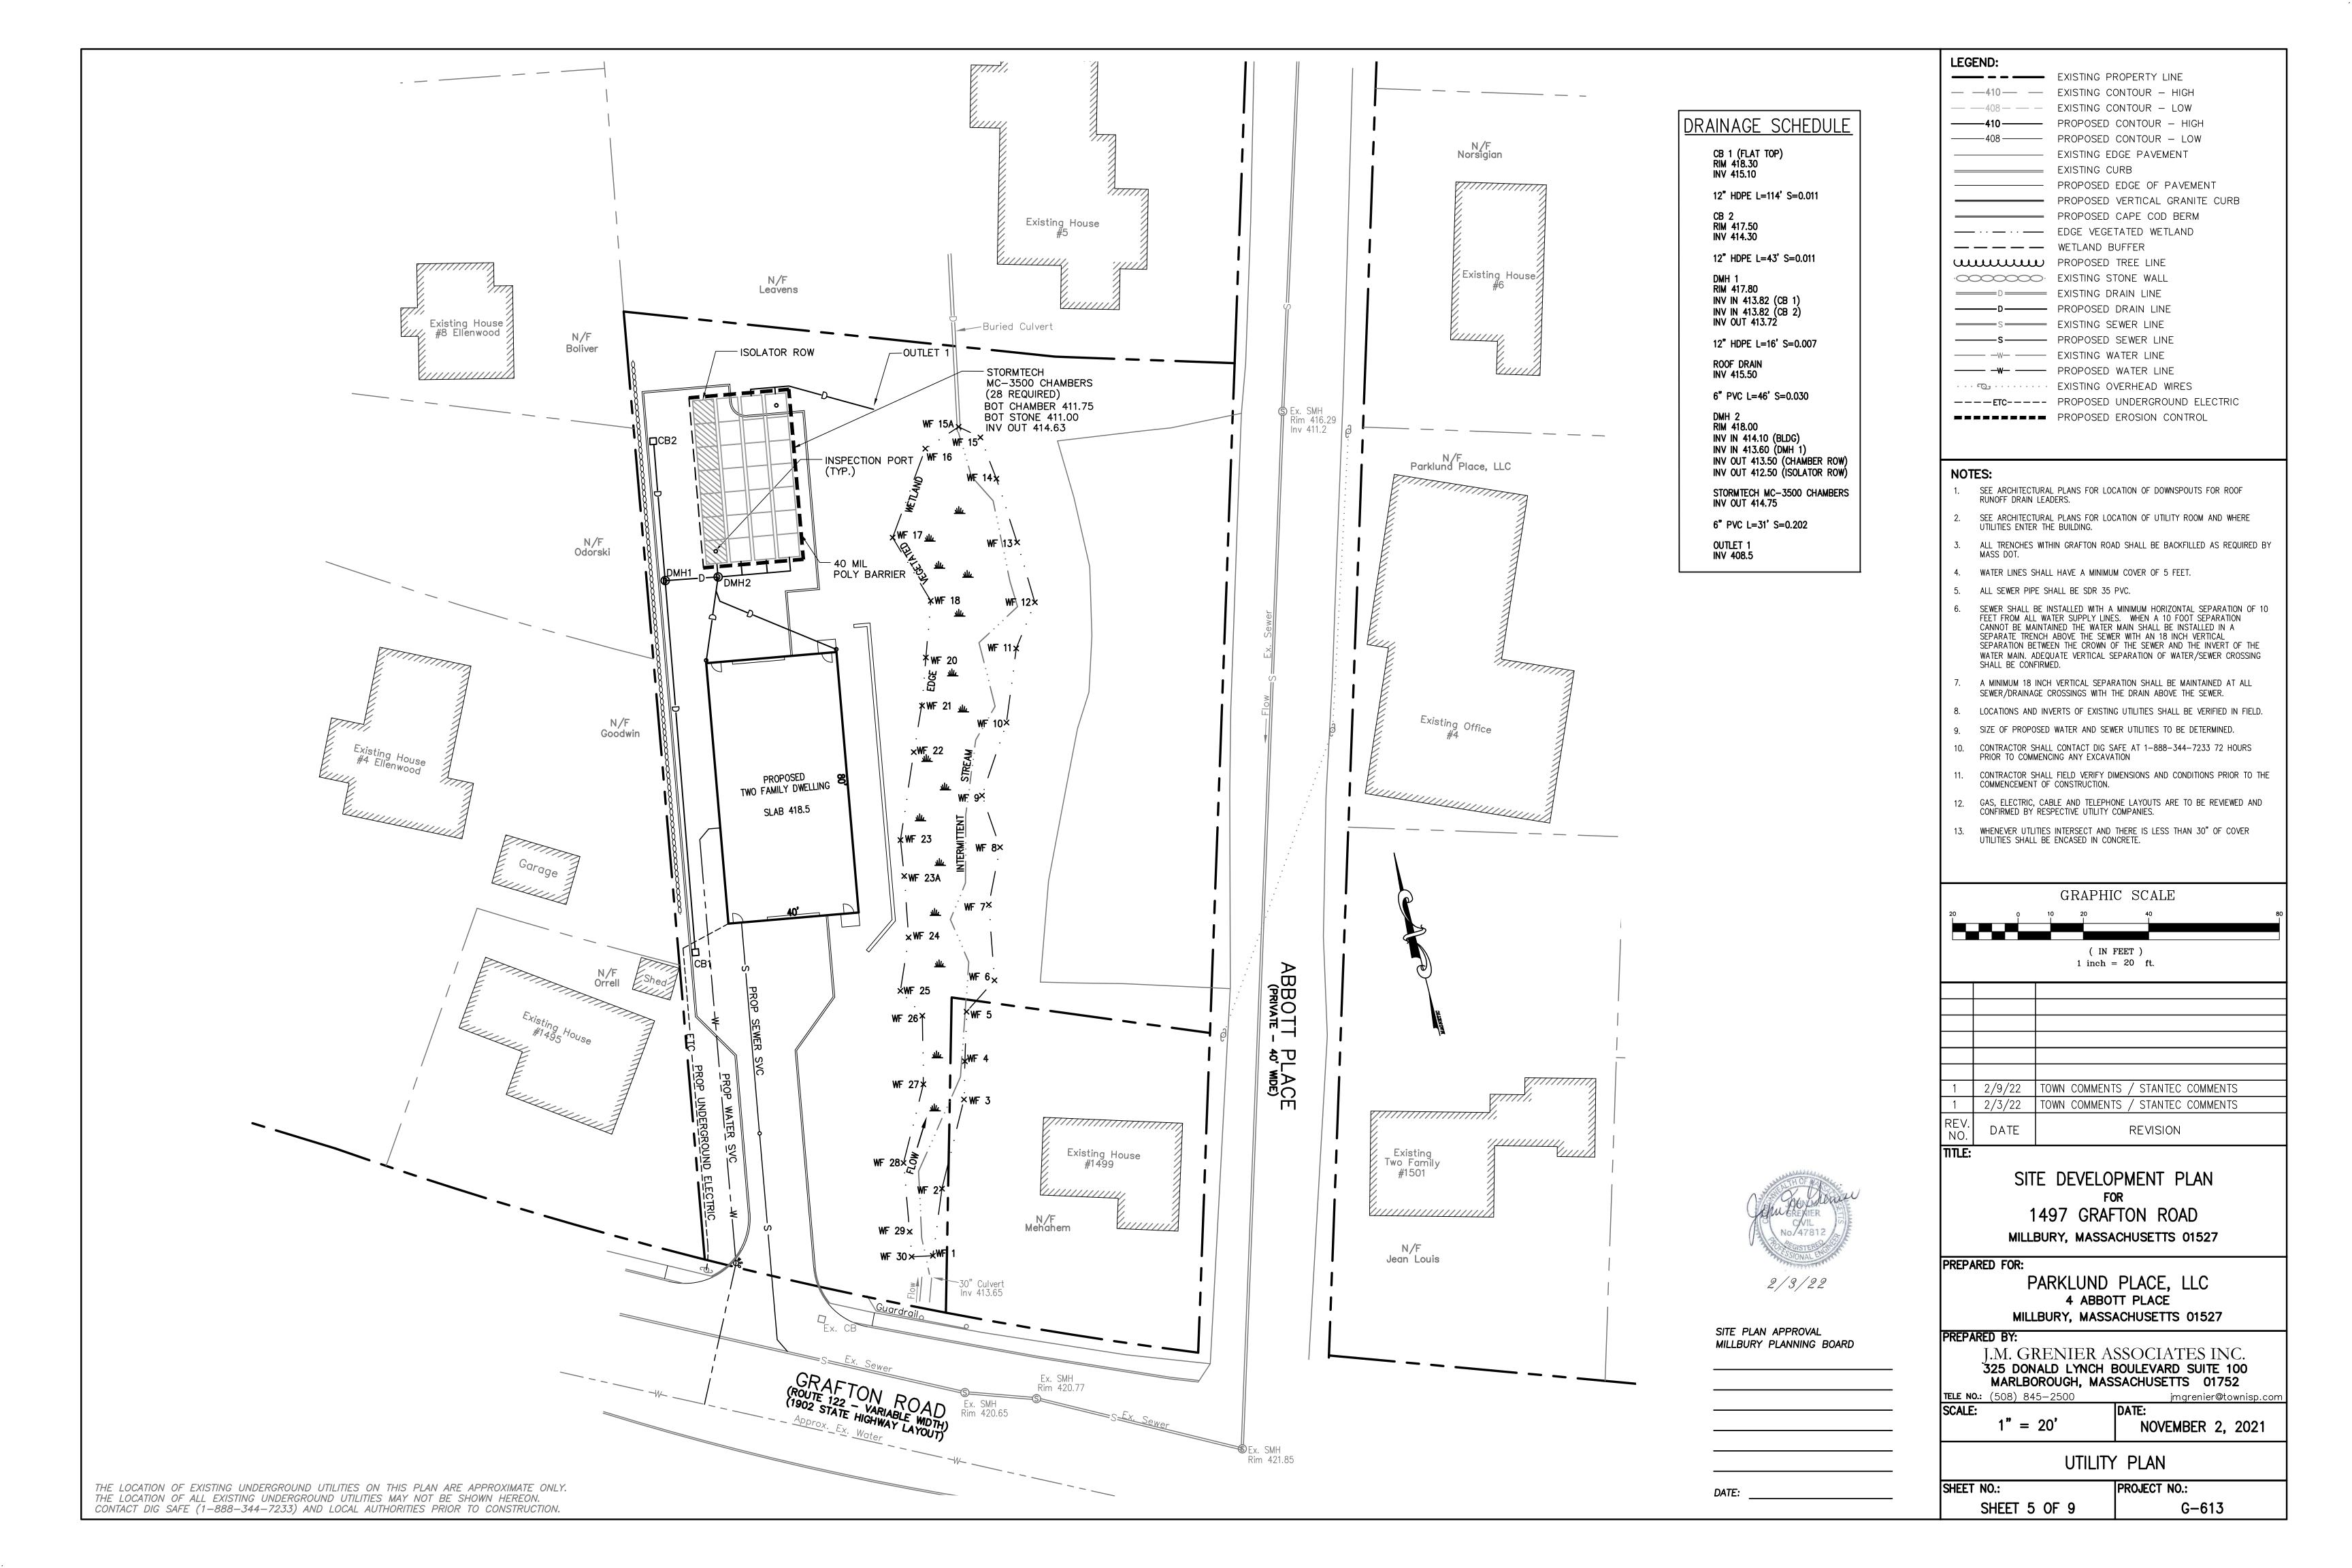
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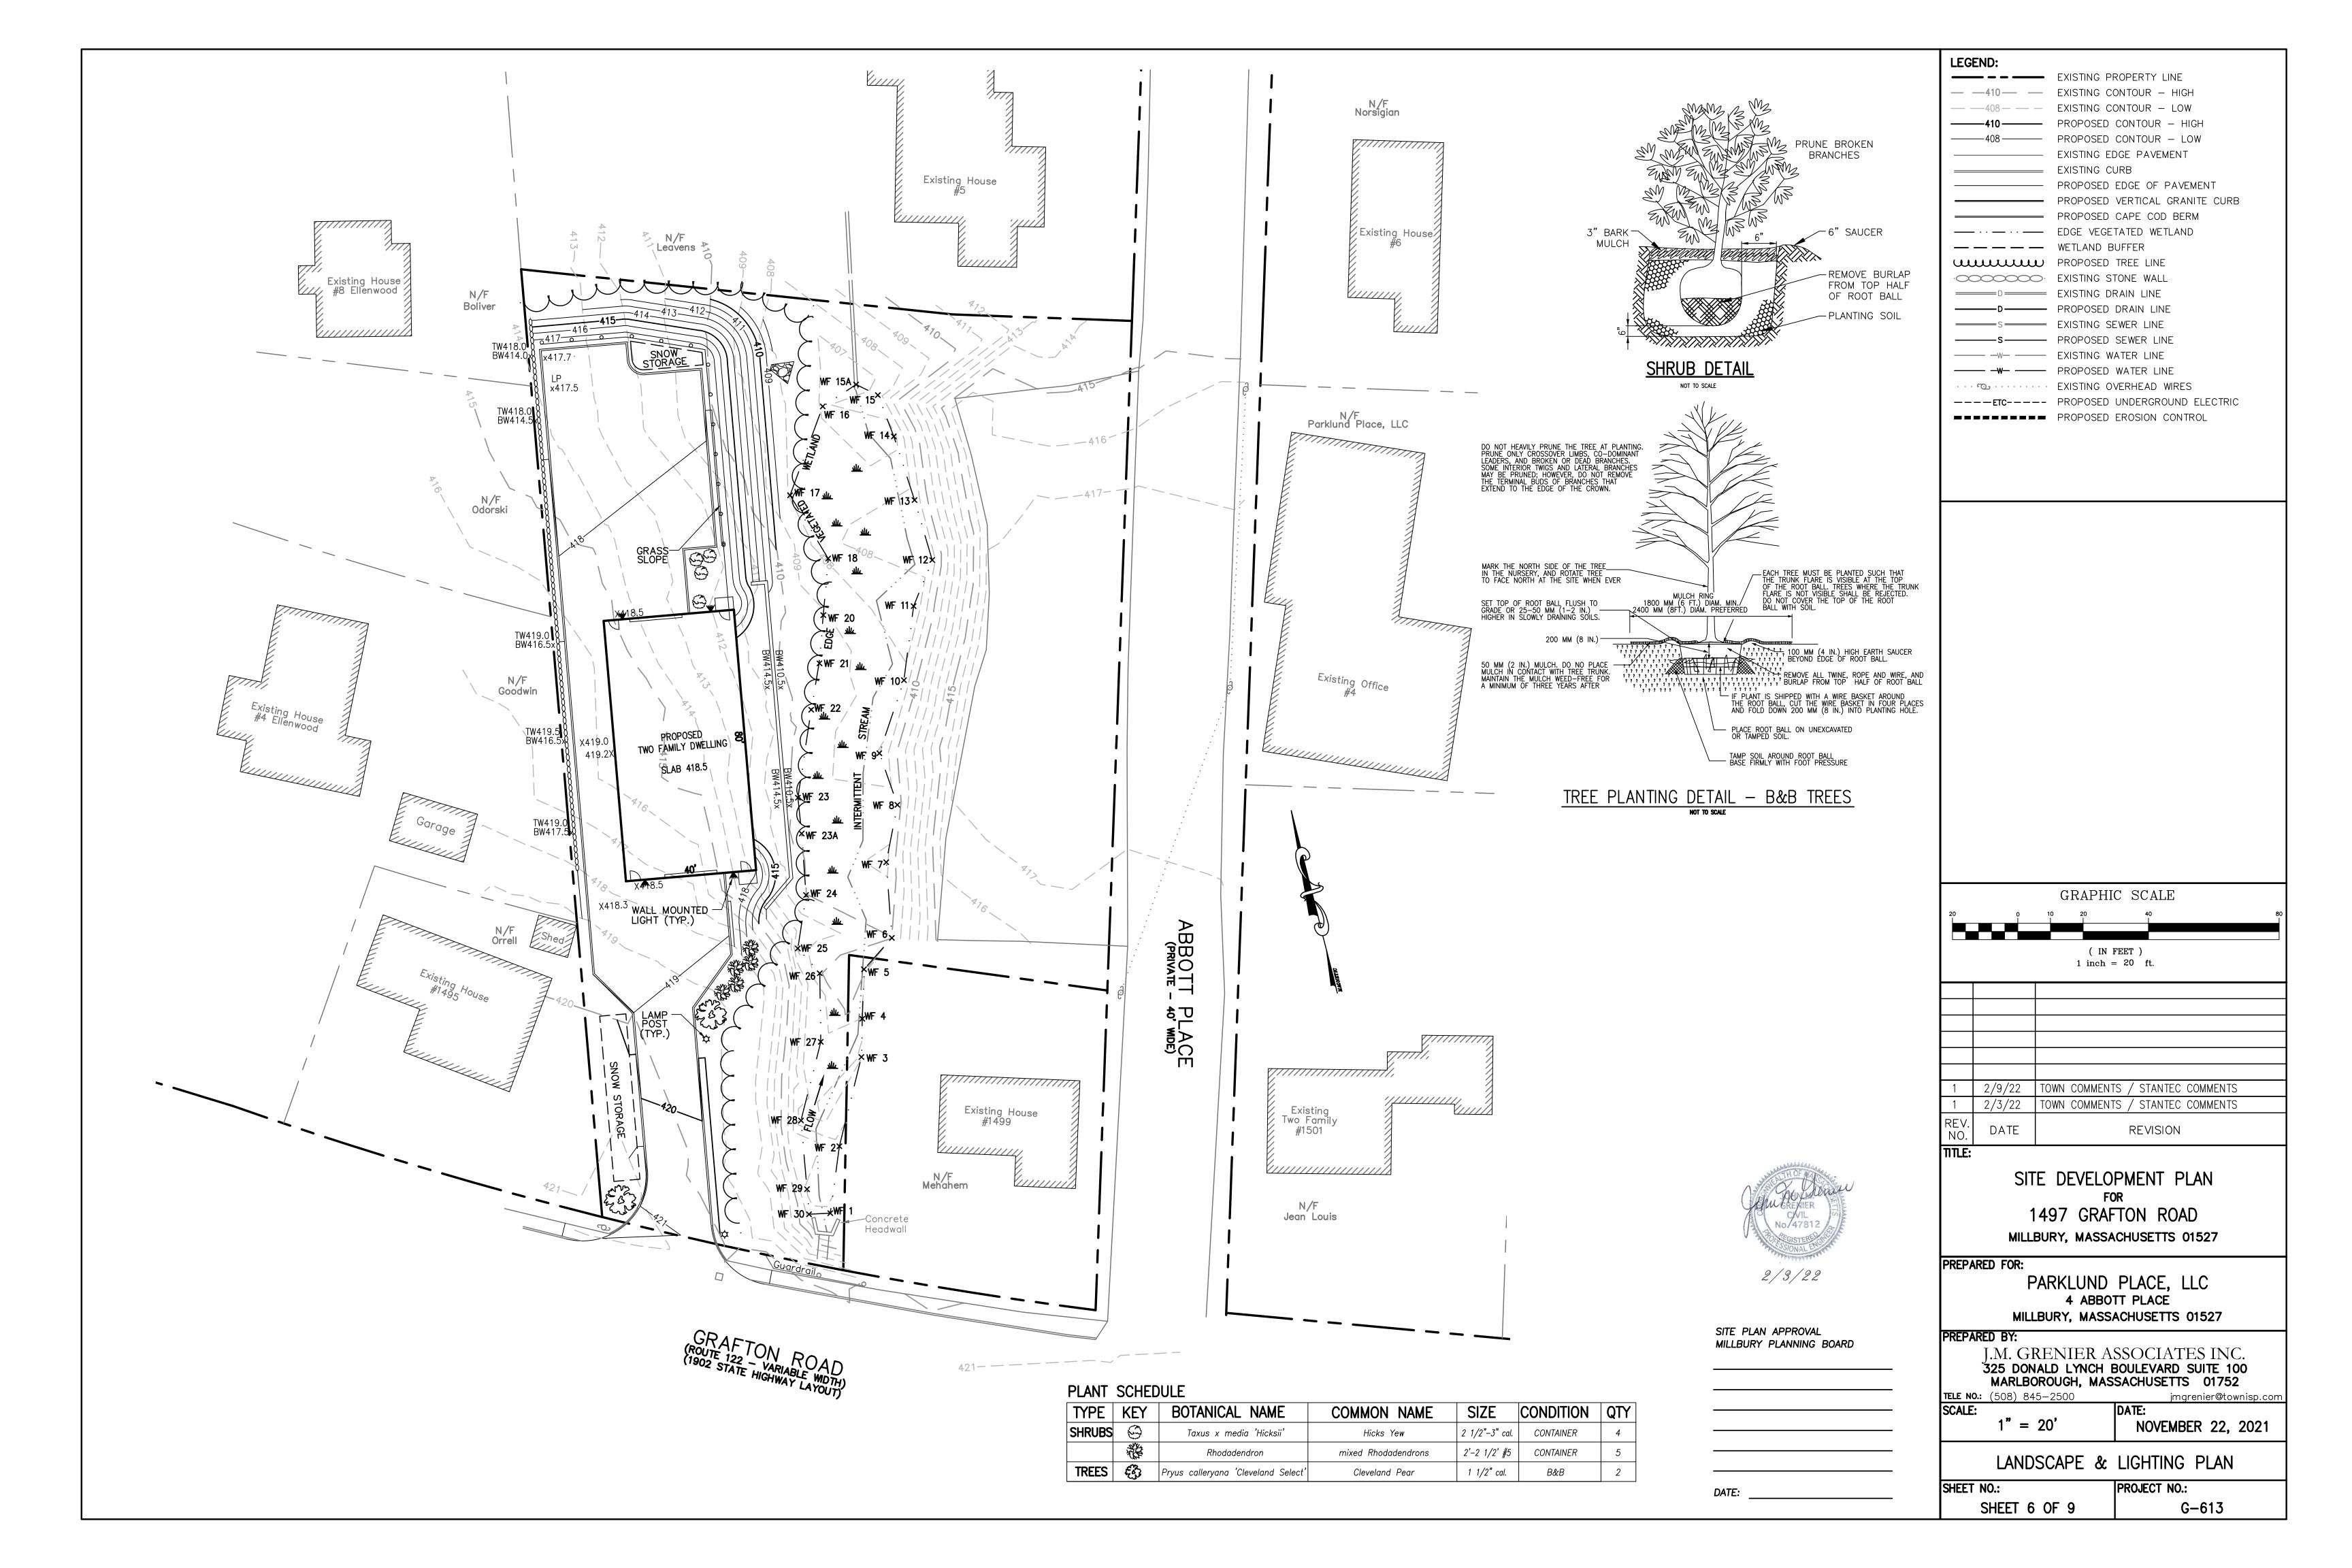
ZONING DISTRICT: EAST MILLBURY BUSINESS









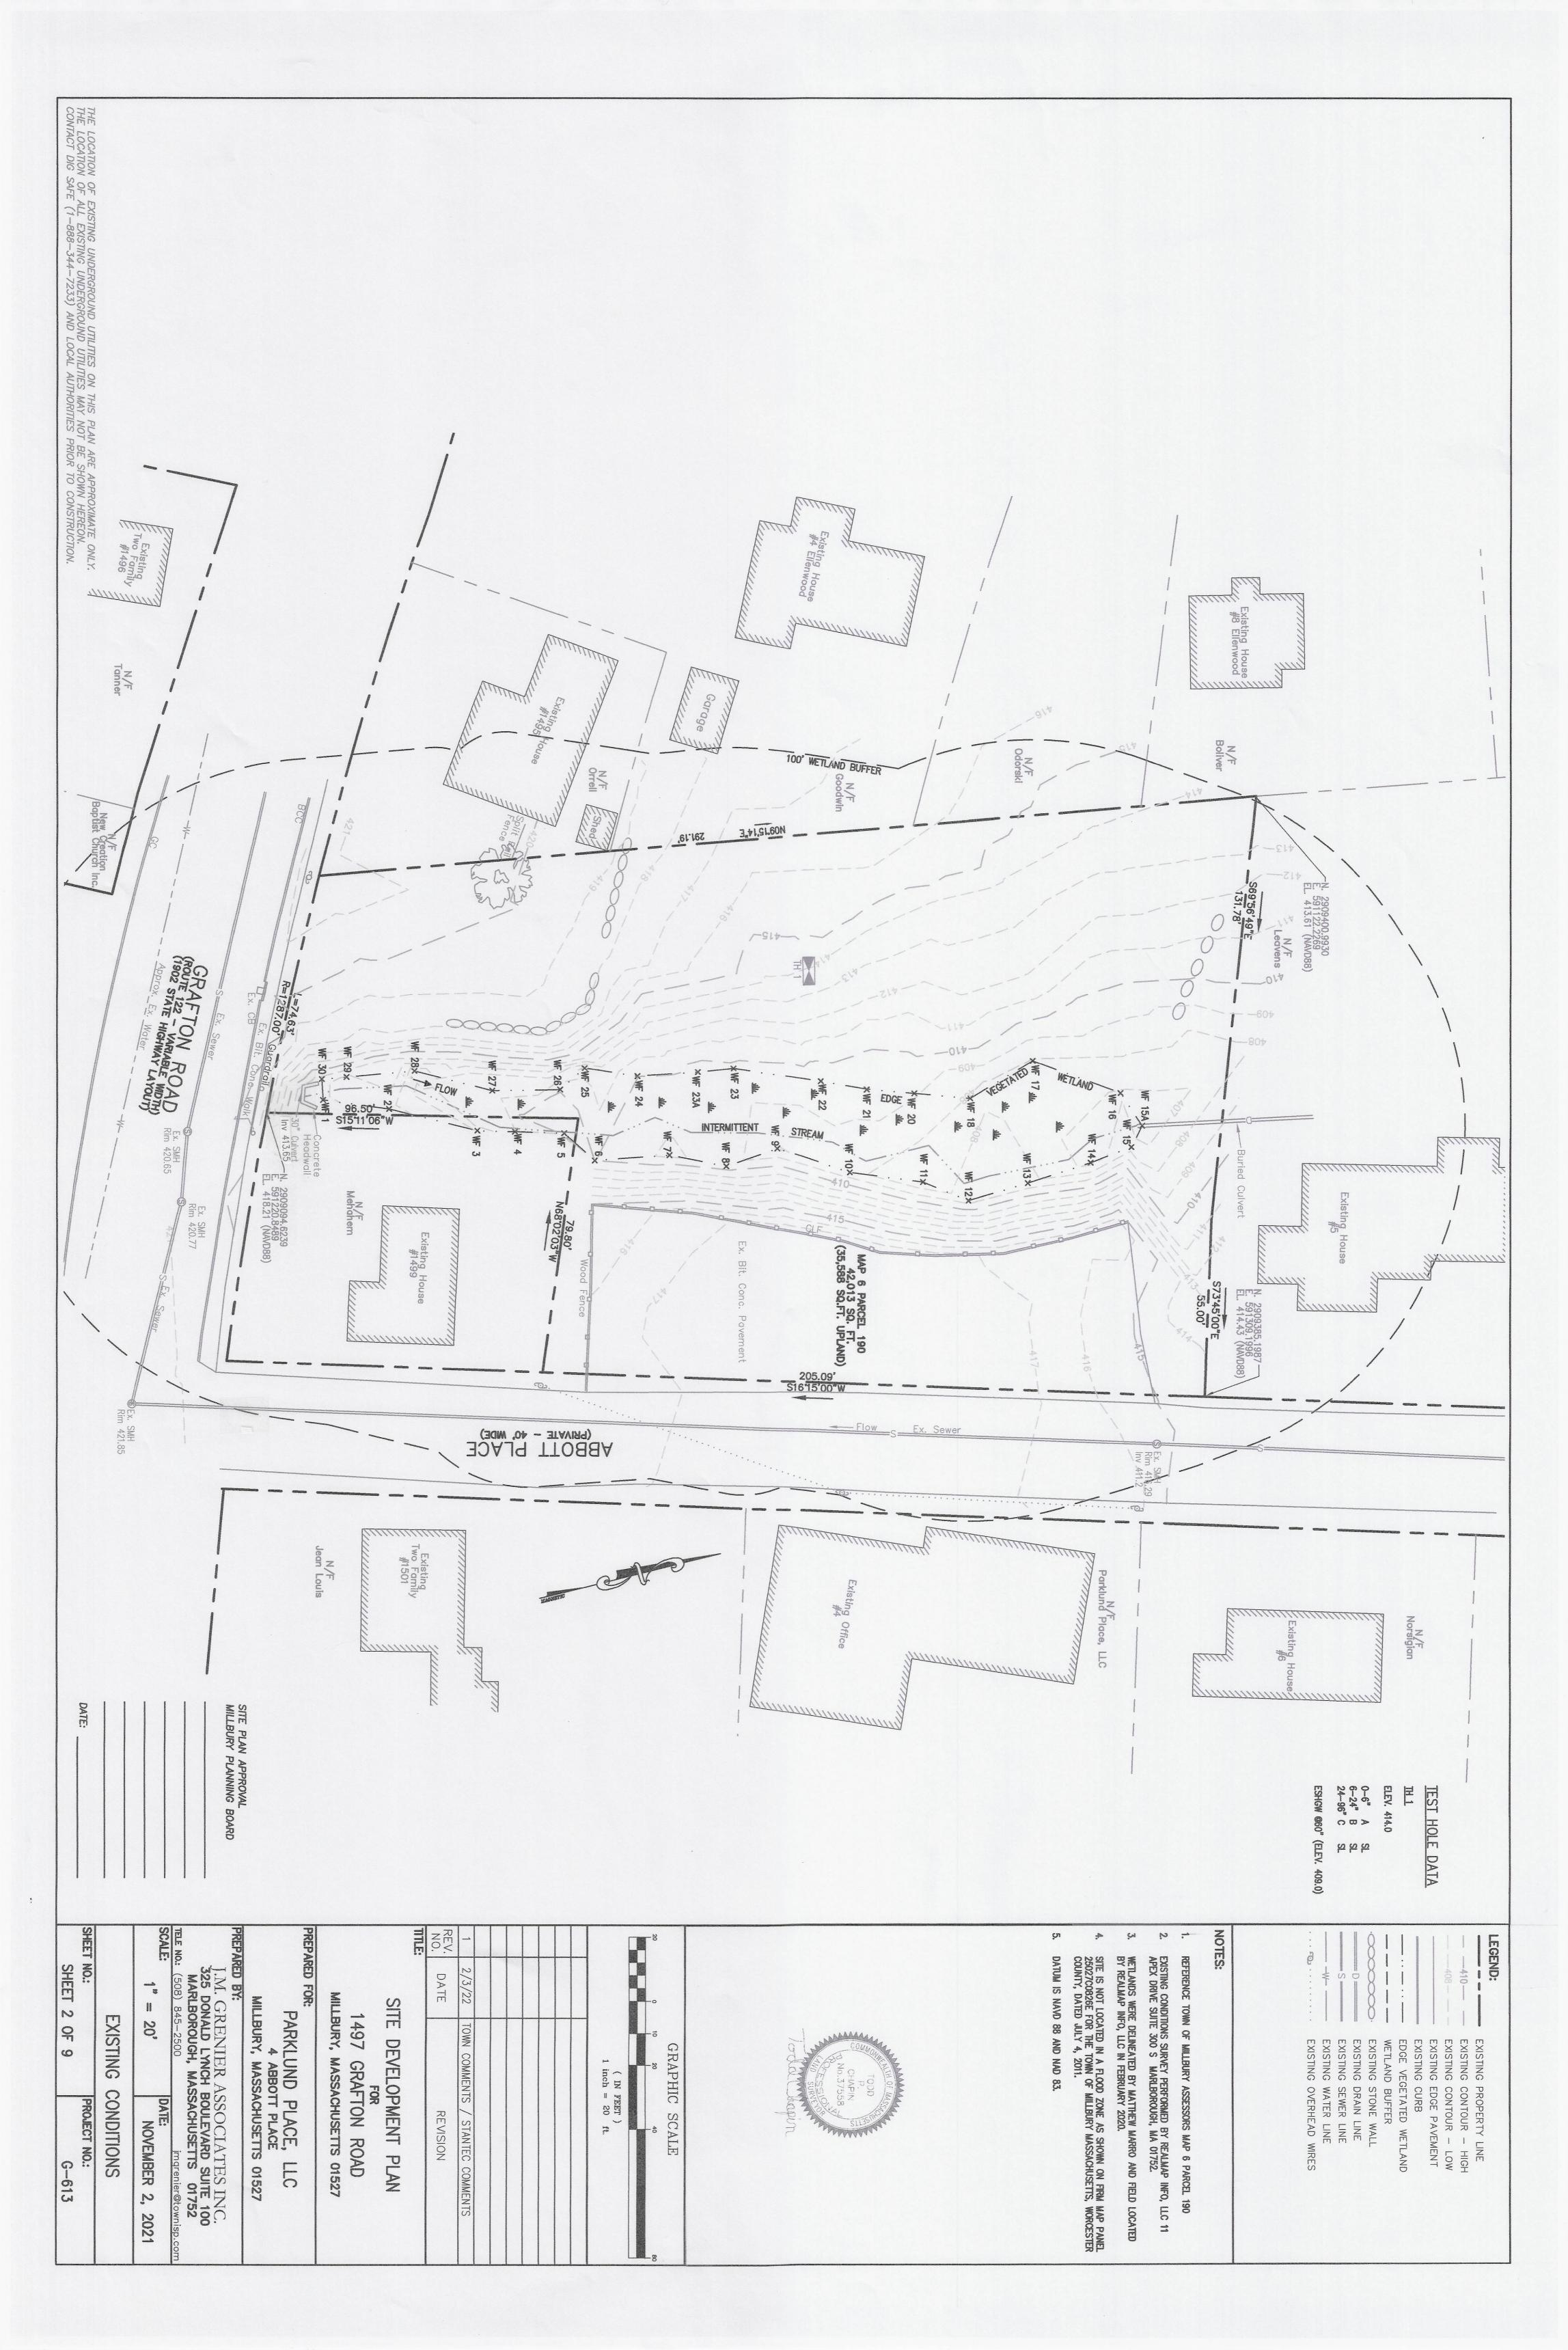

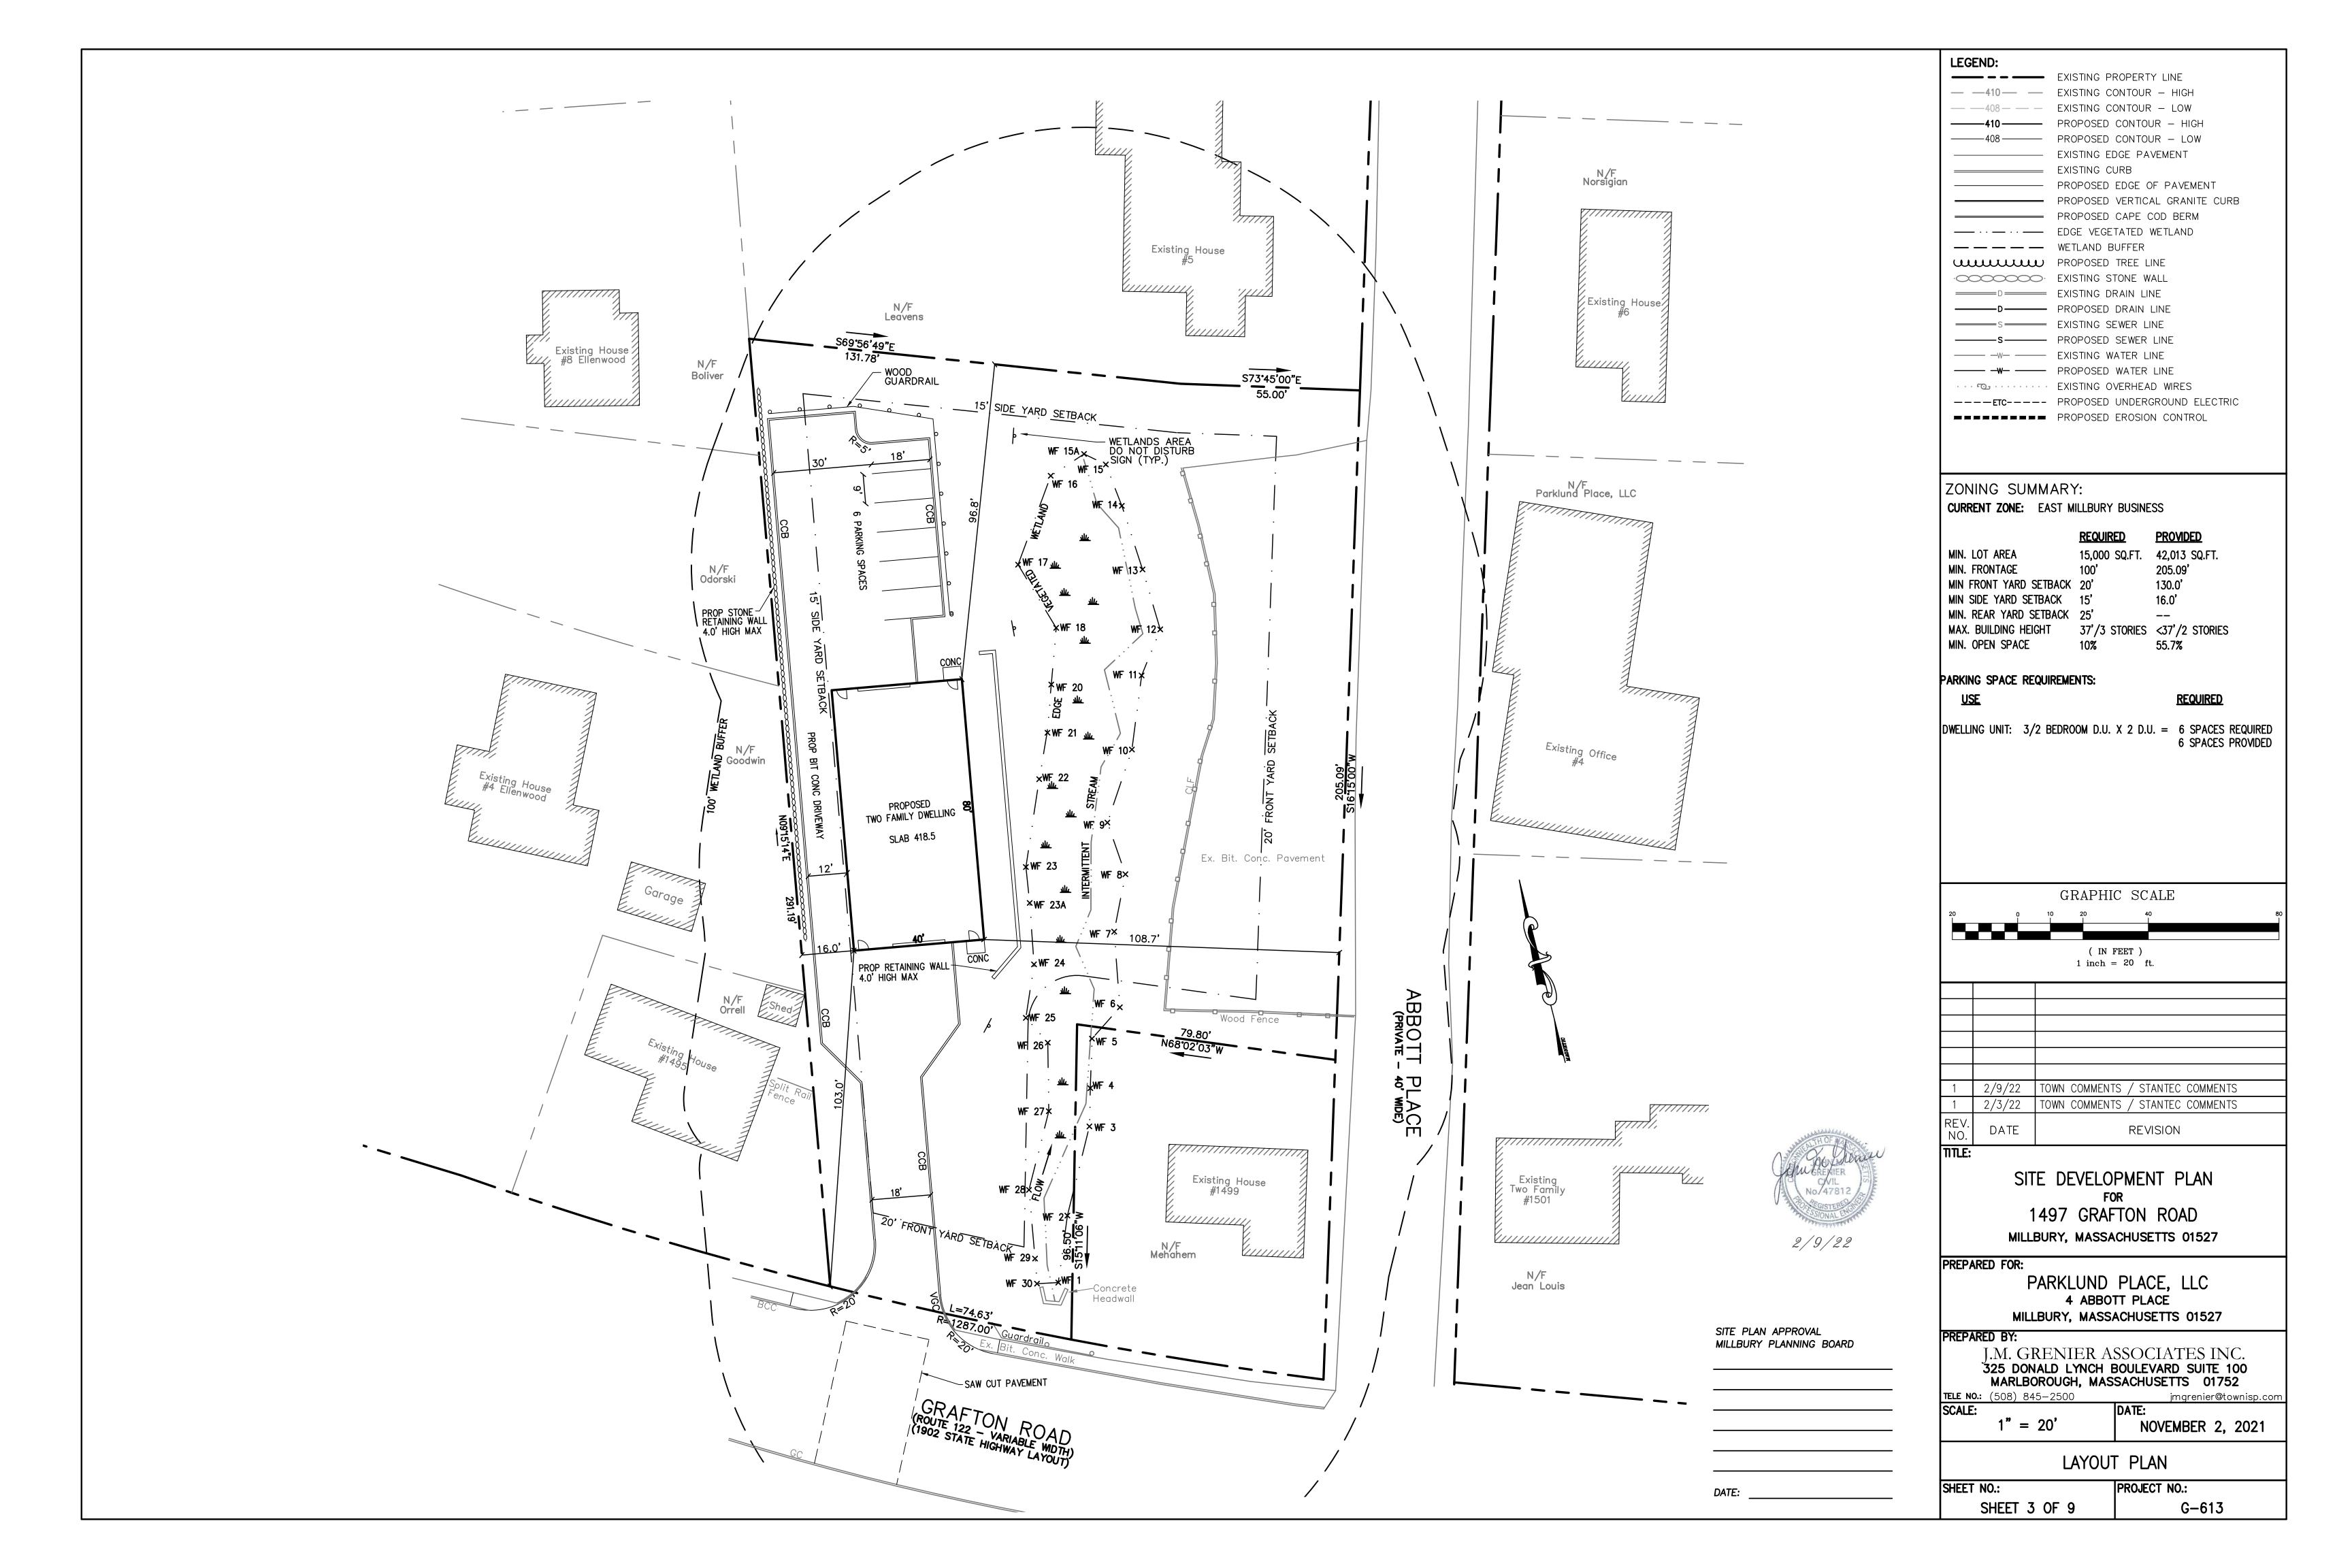

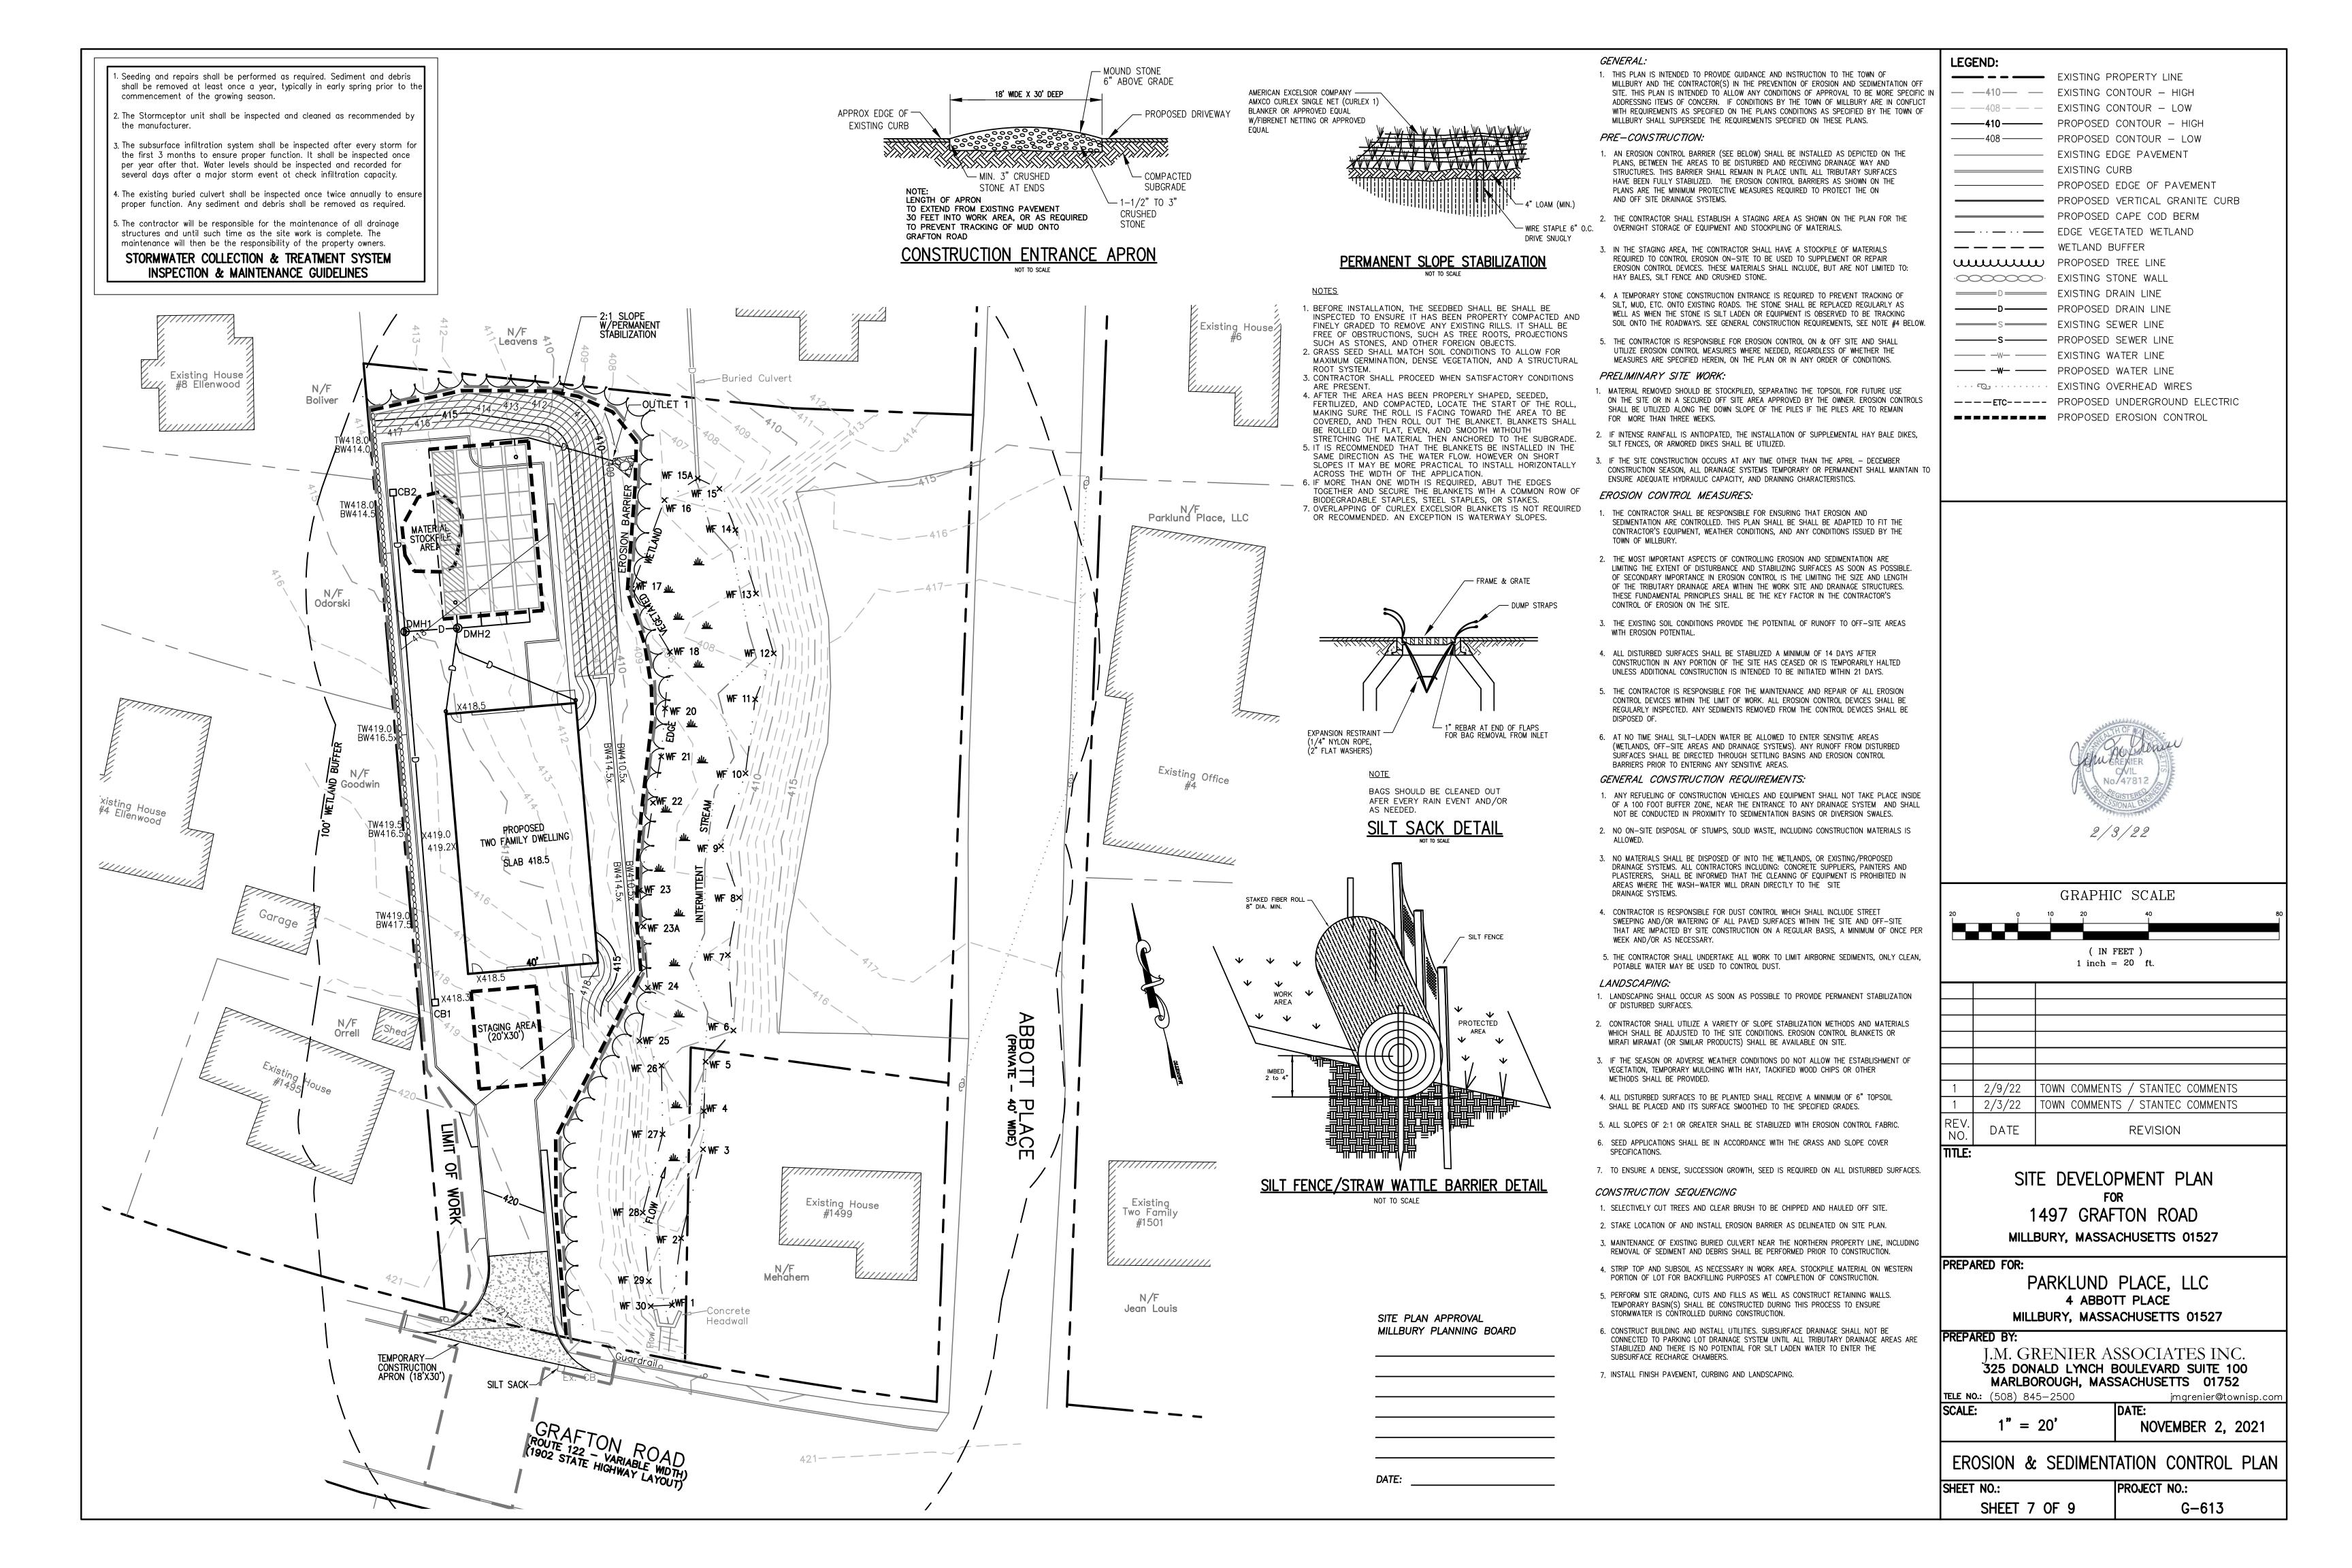


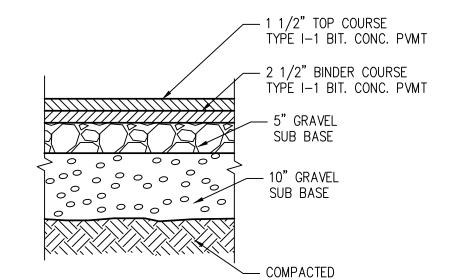



SUBGRADE

STANDARD BITUMINOUS CONCRETE PAVEMENT


NOT TO SCALE

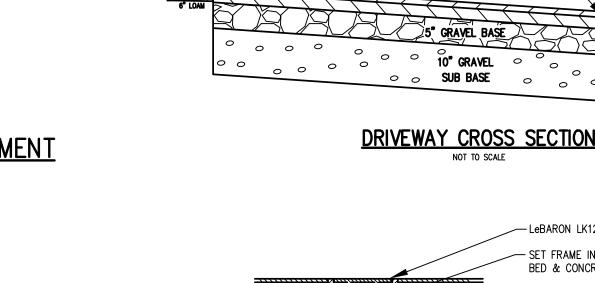

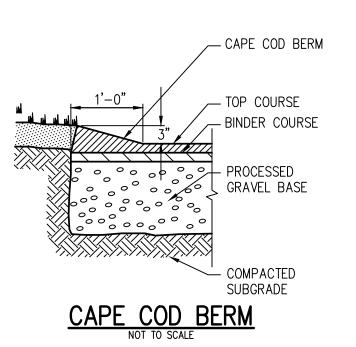


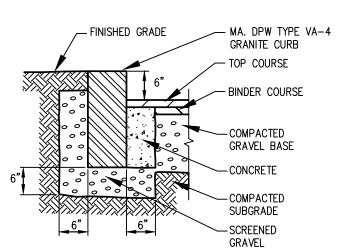


VERTICAL GRANITE CURB

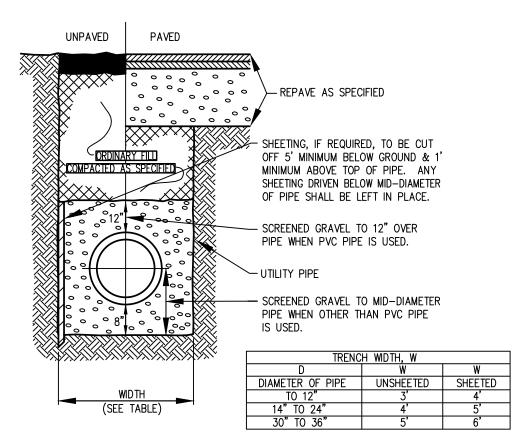

TYPICAL TRENCH SECTION

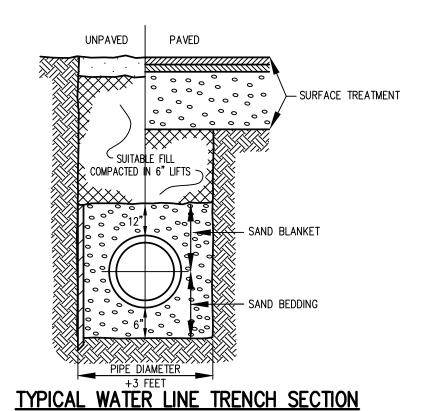

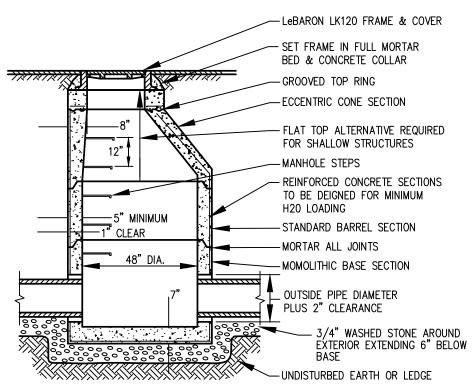


VERTICAL GRANITE CURB


1 1/2" TOP COURSE -

2 1/2" BINDER COURSE-

PRECAST CONCRETE DRAIN MANHOLE

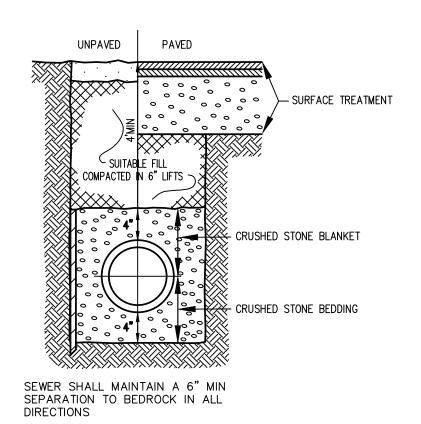


TYPICAL SEWER TRENCH SECTION

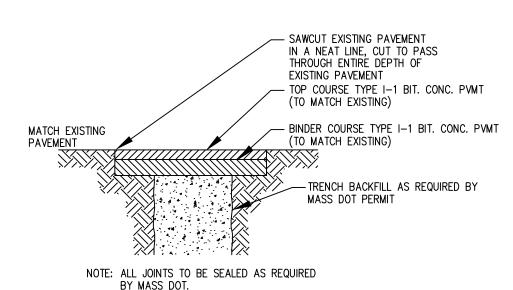

PERMANENT PAVEMENT REPAIR

NOT TO SCALE

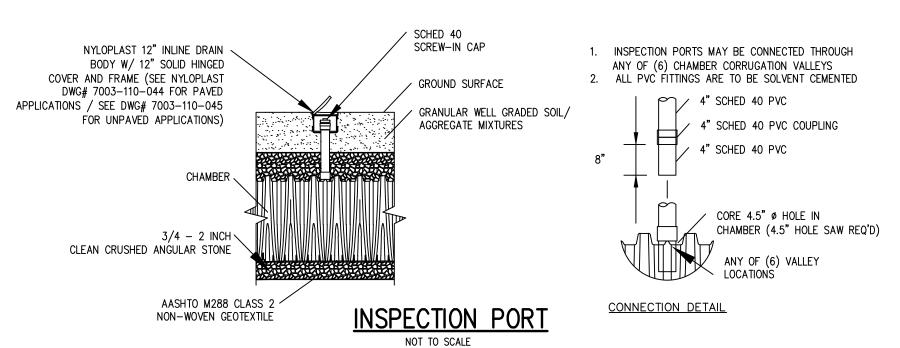


ACCEPTABLE FILL MATERIALS: STORMTECH CHAMBER SYSTEMS


MATERIAL LOCATION		DESCRIPTION	AASHTO M43 DESIGNATION¹	COMPACTION/DENSITY REQUIREMENT
(D)	FILL MATERIAL FOR LAYER 'D' STARTS FROM THE TOP OF THE 'C' LAYER TO THE BOTTOM OF FLEXIBLE PAVEMENT OR UNPAVED FINISHED GRADE ABOVE. NOTE THAT PAVEMENT SUBBASE MAY BE PART OF THE 'D' LAYER.	ANY SOIL/ROCK MATERIALS, NATIVE SOILS, OR PER ENGINEER'S PLANS. CHECK PLANS FOR PAVEMENT SUBGRADE REQUIREMENTS.	N/A	PREPARE PER ENGINEER'S PLANS. PAVED INSTALLATIONS MAY HAVE STRINGENT MATERIAL AND PREPARATION REQUIREMENTS.
©	FILL MATERIAL FOR LAYER 'C' STARTS FROM THE TOP OF THE EMBEDMENT STONE ('B' LAYER) TO 24" [610 mm] ABOVE THE TOP OF THE CHAMBER. NOTE THAT PAVEMENT SUBBASE MAY BE A PART OF THIS LAYER.	GRANULAR WELL-GRADED SOIL/AGGREGATE MIXTURES, < 35% FINES. MOST PAVEMENT SUBBASE MATERIALS CAN BE USED IN LIEU OF THIS LAYER.	3, 357, 4, 467, 5, 56, 57, 6, 67, 68, 7, 78, 8, 89, 9, 10	BEGIN COMPACTION AFTER 24" [610 mm] OF MATERIAL OVER THE CHAMBERS IS REACHED. COMPACT ADDITIONAL LAYERS IN 6" [152 mm] LIFTS TO A MIN. 95% STANDARD PROCTOR DENSITY.
B	EMBEDMENT STONE SURROUNDING THE CHAMBERS FROM THE FOUNDATION STONE TO THE 'C' LAYER ABOVE.	CLEAN, CRUSHED, ANGULAR STONE, NOMINAL SIZE DISTRIBUTION BETWEEN 3/4 - 2 INCH [19 - 51 mm]	3, 357, 4, 467, 5, 56, 57	NO COMPACTION REQUIRED.
A	FOUNDATION STONE BELOW CHAMBERS FROM THE SUBGRADE UP TO THE FOOT (BOTTOM) OF THE CHAMBER.	CLEAN, CRUSHED, ANGULAR STONE, NOMINAL SIZE DISTRIBUTION BETWEEN 3/4 - 2 INCH [19 - 51 mm]	3, 35, 4, 467, 5, 56, 57	PLATE COMPACT OR ROLL TO ACHIEVE A 95% STANDARD PROCTOR DENSITY ² .

PLEASE NOTE:

1. THE LISTED AASHTO DESIGNATIONS ARE FOR GRADATIONS ONLY. THE STONE MUST ALSO BE CLEAN, CRUSHED, ANGULAR. FOR EXAMPLE, A SPECIFICATION FOR #4 STONE WOULD STATE: "CLEAN, CRUSHED, ANGULAR NO. 4 (AASHTO M43) STONE".

2. AS AN ALTERNATE TO PROCTOR TESTING AND FIELD DENSITY MEASUREMENTS ON OPEN GRADED STONE, STORMTECH COMPACTION REQUIREMENTS ARE MET FOR 'A' LOCATION MATERIALS WHEN PLACED AND COMPACTED IN 9" [229 mm] (MAX) LIFTS USING TWO FULL COVERAGES WITH AN APPROPRIATE COMPACTOR.

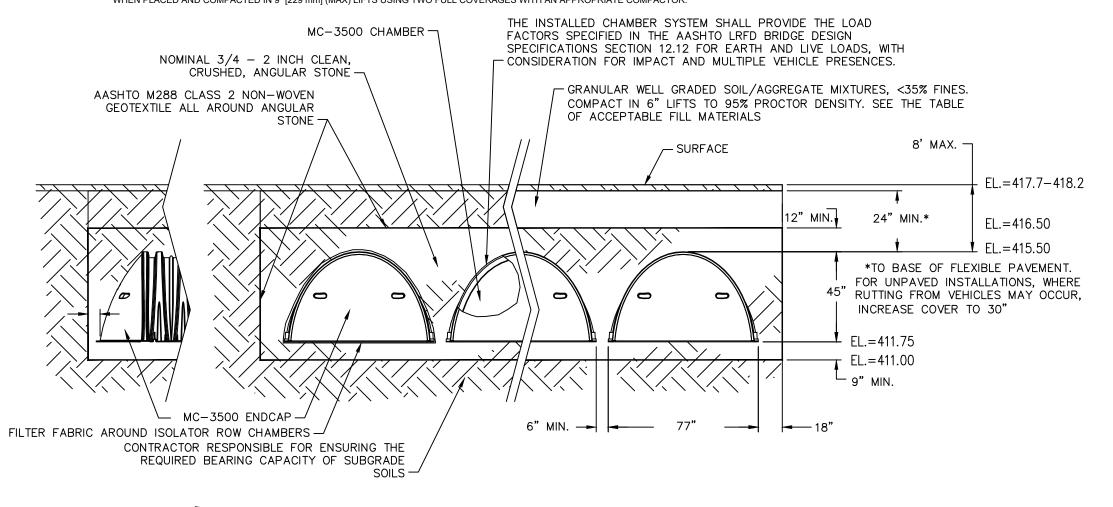

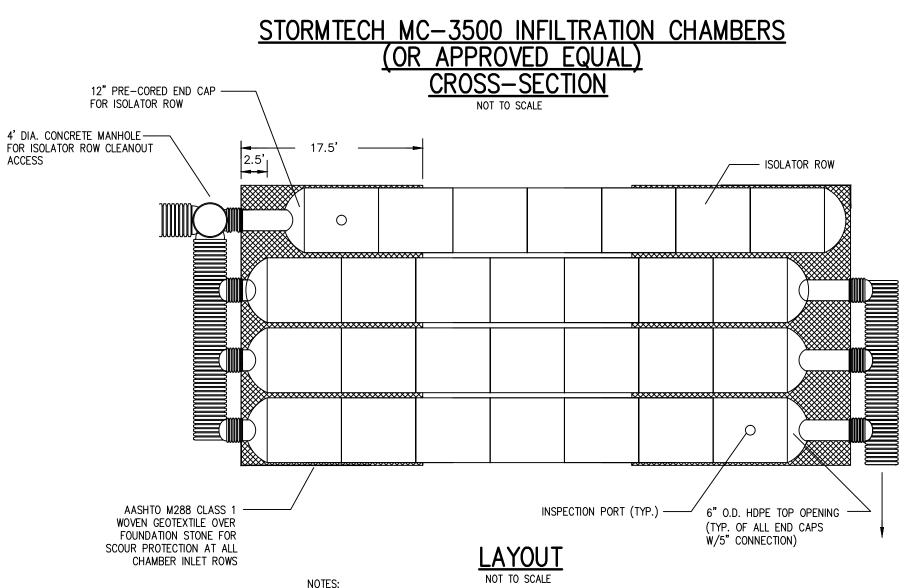

ESHGW ELEV.

1. ALL DESIGN SPECIFICATIONS FOR STORMTECH MC-3500 CHAMBERS SHALL BE IN ACCORDANCE WITH THE STORMTECH MC-3500 DESIGN MANUAL.

2. THE INSTALLATION OF STORMTECH MC-3500 CHAMBERS SHALL BE IN ACCORDANCE WITH THE LATEST STORMTECH MC-3500 INSTALLATION INSTRUCTIONS.


3. THE CONTRACTOR IS ADVISED TO REVIEW AND UNDERSTAND THE INSTALLATION INSTRUCTIONS PRIOR TO BEGINNING SYSTEM INSTALLATION. CALL 1-888-892-2694
TO RECIEVE A COPY OF THE LATEST STORMTECH MC-3500 INSTALLATION INSTRUCTIONS.

4. CHAMBERS SHALL MEET THE DESIGN REQUIREMENTS AND LOAD FACTORS SPECIFIED IN SECTION 12.12 OF THE LATEST EDITION OF THE AASHTO LRFD BRIDGE DESIGN SPECIFICATIONS.




SITE PLAN	APPROVAL	-
MILLBURY	PLANNING	BOARD


DATE:

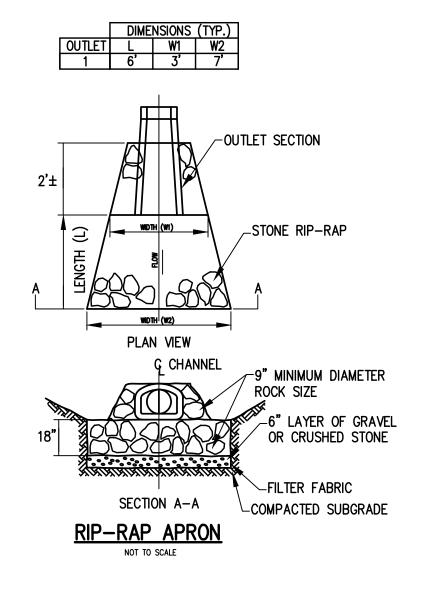

1	2/3/22	TOWN COMMENT	S / STANTEC COMMENTS		
10. EV.	DATE		REVISION		
TLE:					
	SITE DEVELOPMENT PLAN FOR				
	1	497 GRAF	TON ROAD		
	MILLBURY, MASSACHUSETTS 01527				
REPA	RED FOR:				
	F	PARKLUND	PLACE, LLC		
	·		IT PLACE		
MILLBURY, MASSACHUSETTS 01527					
REPARED BY:					
			SSOCIATES INC.		
	325 DONALD LYNCH BOULEVARD SUITE 100				
MARLBOROUGH, MASSACHUSETTS 01752 LE NO.: (508) 845–2500 jmgrenier@townisp.com					
ALE	•		DATE:		
	N.T.	S.	NOVEMBER 2, 2021		
DETAIL PLAN 1/2					
IEET NO.: PROJECT NO.:			PROJECT NO.:		
SHEET 8 OF 9			G-613		


2/9/22 | TOWN COMMENTS / STANTEC COMMENTS

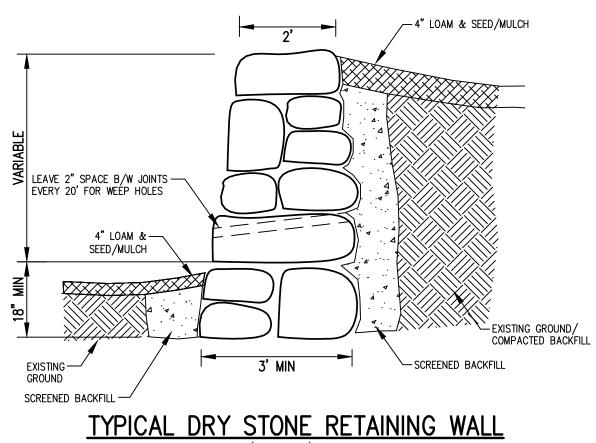


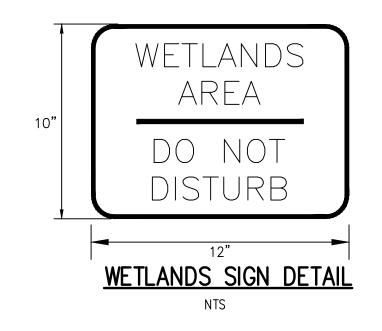


(OR EQUAL) NOT TO SCALE



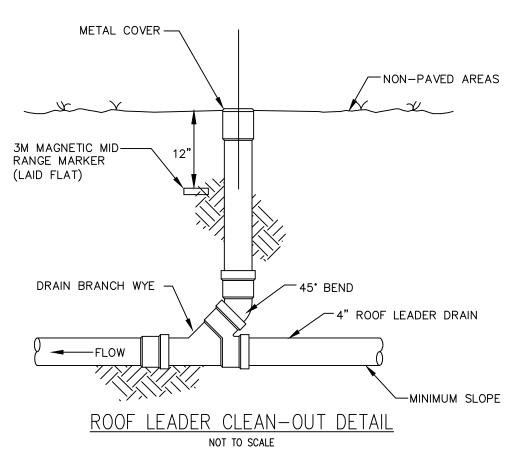


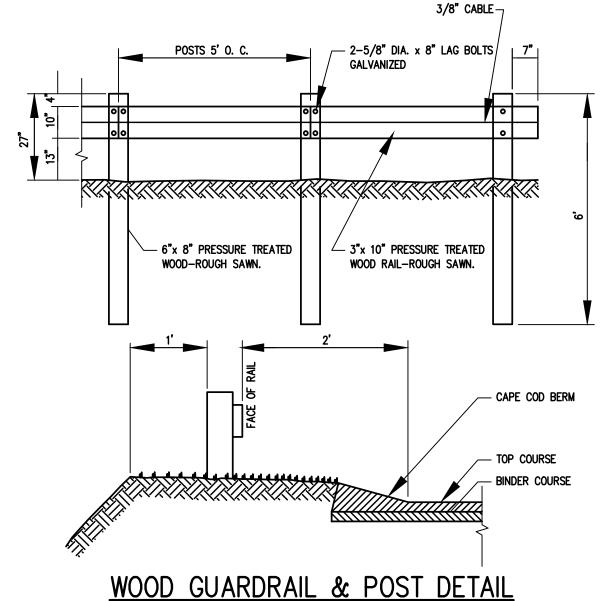

NOT TO SCALE

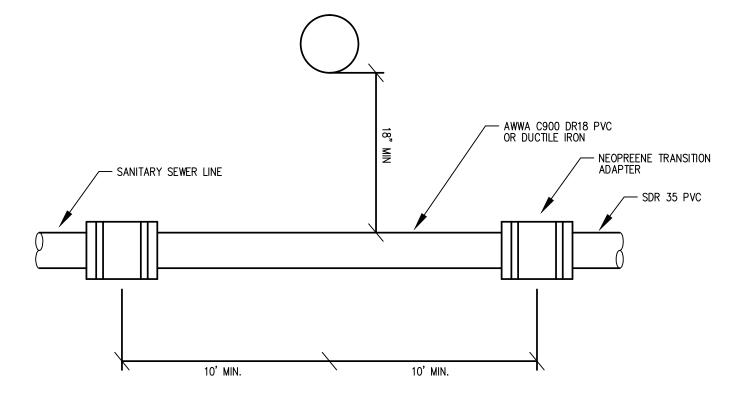

WATER AND SEWER CROSSING
WITH VERTICAL CLEARANCE LESS THAN 2' NOT TO SCALE

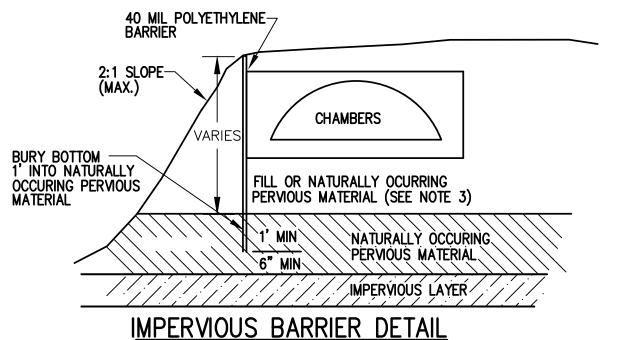


NOTES:

- 1. THE PURPOSE OF THE IMPERVIOUS BARRIER IS TO PREVENT BREAKOUT OF WATER FROM THE ADJACENT SLOPE.
- 2. FILL AND SLOPE SHALL BE CREATED FIRST. THEN AREA FOR RECHARGE CHAMBERS SHALL BE EXCAVATED POLY BARRIER PLACED AT LIMIT OF CHAMBER FIELD AS SHOWN.
- 3. FILL MATERIAL SHALL BE FREE OF BOULDERS, ORGANICS OR OTHER DELETERIOUS MATERIALS. BACKFILL SHALL BE PLACED AND SPREAD UNIFORMLY IN SUCCESSIVE LIFTS NOT TO EXCEED 12" IN LOOSE THICKNESS. EACH LAYER SHALL BE COMPACTED TO A MINIMUM OF 95% OF MAXIMUM DENSITY.

Typical Physical Property Values of our Chemical Resistant 40mil Polyethylene Breakout Barrier Material

roperties	Test Method	Minimum Roll Averages	Typical Roll Averages
hickness mils (mm)	ASTM D 1583	37 (0.94)	40 (1.02)
ensity lb/ft3	ASTM D792 or ASTM D1505		57.7 (.925)
linimum Tensile /in, width 4 (147) I/cm width)	ASTM D638 1. Tensile strength at yield 2. % elongation at yield 3. Tensile strength at break 4. % elongation at break 5. Modulus @100% elongation	80 (140) 13 175 (314) 650	84 (147) 13 175 (314) 700 68 (119)
ydrostatic Resistance psi (kPa)	ASTM D751	230 (1586)	250 (1724)
uncture Resistance lbf (N)	FTMS 101 C - Method 2065	61 (271)	65 (289)
ear Resistance lbf (N)	ASTM D1004	24 (107)	26 (116)
olatile Loss - Method A	AASTM 1203		< 1%
esistance to Soil urial (% change aximum in riginal value)	ASTM G22 1. Tensile strength at yield 2. Tensile strength at break 3. Elongation at yield 4. Elongation at break 5. Modulus of elasticity		- 4%
ow Temp, Impact Failure emp F (C)	ASTM D746		< .70 (< .94)
imensional Stability Change	ASTM D1204		< 2
nvironmental Stress Crack esistance Hours to Failure	ASTM D5397 Method A		> 400
arbon Black %	ASTM D1803	2.5	2.75
/VTR gH2O/100 in2/24 hrs gH2O/m2/24 hrs)	ASTM E96 Method A 73o F, 50% RH		.016 (.018)
erms graines/ft2/hr/in.Hg grams/m2/day/mm Hg	ASTM E96 Method A 73o F, 50% RH		.021 (.026)
actory Seam Requirements			
onded Seam Strength f/in. width (N/cm width)	ASTM D4437	72 (126)	80 (140)
	ASTM D4437	56	62

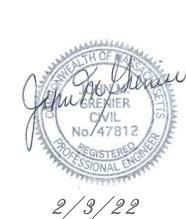

SITE PLAN APPROVAL MILLBURY PLANNING BOARD

	2/9/22	TOWN COMMENTS / STANTEC COMMENTS
	2/3/22	TOWN COMMENTS / STANTEC COMMENTS
∑V. O.	DATE	REVISION
1		

SITE DEVELOPMENT PLAN 1497 GRAFTON ROAD MILLBURY, MASSACHUSETTS 01527

PREPARED FOR:

PARKLUND PLACE, LLC 4 ABBOTT PLACE MILLBURY, MASSACHUSETTS 01527

PREPARED BY:

J.M. GRENIER ASSOCIATES INC. 325 DONALD LYNCH BOULEVARD SUITE 100 MARLBOROUGH, MASSACHUSETTS 01752

TELE NO.: (508) 845-2500 jmgrenier@townisp.com SCALE: N.T.S. NOVEMBER 2, 2021

DETAIL PLAN 2/2

SHEET NO.: SHEET 9 OF 9 PROJECT NO.: G-613